



Elevation B-B Existing: Road Bridge East Elevation

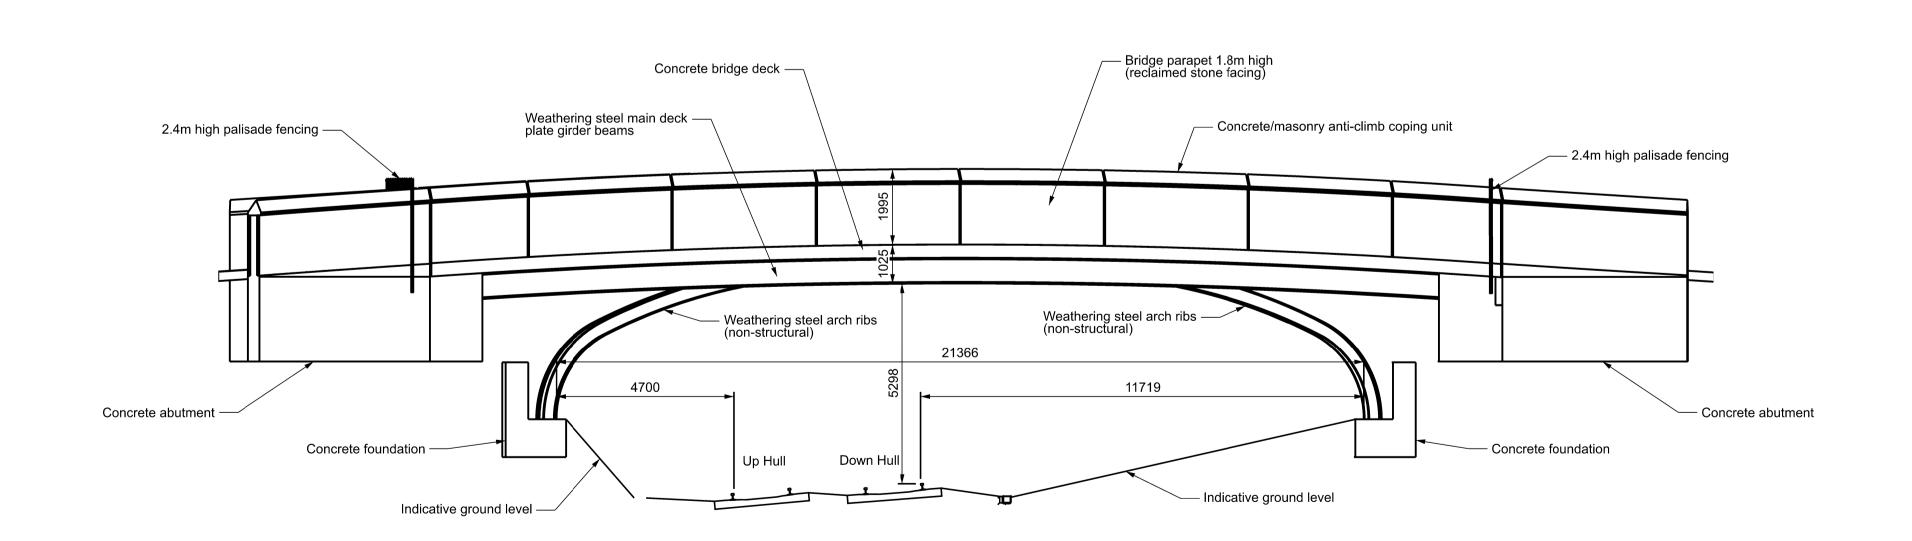


Elevation B-B Proposed: Road Bridge East Elevation Scale 1:100

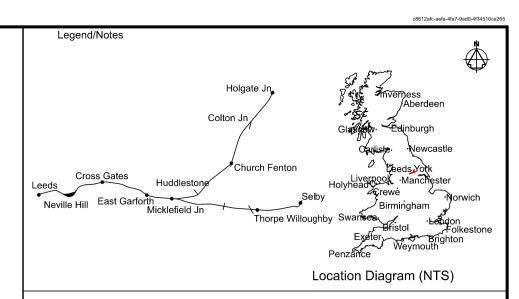

#### Leeds to Micklefield Enhancements Order

Note

- 1. All dimensions are in millimetres unless stated otherwise.
- 2. Do not scale from this drawing.
- 3. In constructing or maintaining the works identified as Scheduled Works in Schedule 1 of the Network Rail (Leeds to Micklefield Enhancements) Order Network Rail may deviate from the dimensions shown on this drawing to the extent permitted by the Order.
- 4. For information on materials and finishes please see D&A Statement.
- 5. This drawing is to be read in conjunction with:
  151666-TRA-00-HUL4-DRG-R-SG-210001 Location Plan
  151666-TRA-00-HUL4-DRG-R-SG-210002 Site Plan
  151666-TRA-00-HUL4-DRG-R-SG-210003 Proposed Detailed Plan
  151666-TRA-00-HUL4-DRG-R-SG-210004 Existing Detailed Plan
  151666-TRA-00-HUL4-DRG-R-SG-210005 Elevations West
  151666-TRA-00-HUL4-DRG-R-SG-210007 Proposed Sections

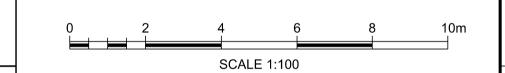

P01	29/06/23	First Issue	ОМ	MW	MW	
P02	29/06/23	Drawing updated to revised model	ОМ	MW	MW	
Rev	Date	Description of Revisions	Drawn	Chk	d Appr	
Fit for Information						



ontractor(s)

Signed

Date

## TRU Alliance

	AREA BDY MICKLEFIELD TO LEEDS CITY STATION					
Type	CAD Drawing	Sub-type Elevation				
Role	Rail Engineering	Sub-Role Signalling				
Zone						
Phasing	Proposed	Project Stage GRIP 4				

## Transpennine Route Upgrade

## Contract No. 151666

## TRU - East of Leeds

Drawing Title

# Replacement Austhorpe Lane Bridge and Gas Main Diversion Existing and Proposed Elevations East

151666-TRA-00-HUL4-DRG-R-SG-210006

Designed	O.McIntosh	Signed	Signed	Date 29/06/23
Drawn	O.McIntosh	Signed	Signed	Date 29/06/23
Checked	M.Westwood	Signed	Signed	Date 29/06/23
Approved	M.Westwood	Signed	Signed	Date 29/06/23
Scale(s)		ELR & Mileage		
1:100		15.1408	to	0
Alternative Re	eference		S	Sheet