


Elevation B-B Existing: Road Bridge East Elevation


Scale 1:100

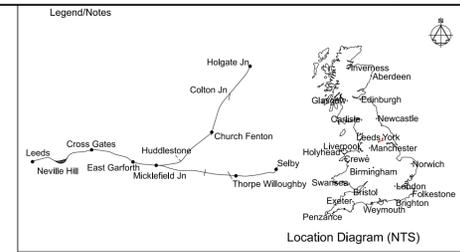

Location Diagram (NTS)

Leeds to Micklefield Enhancements Order

- Notes
1. All dimensions are in millimetres unless stated otherwise.
 2. Do not scale from this drawing.
 3. In constructing or maintaining the works identified as Scheduled Works in Schedule 1 of the Network Rail (Leeds to Micklefield Enhancements) Order Network Rail may deviate from the dimensions shown on this drawing to the extent permitted by the Order.
 4. For information on materials and finishes please see D&A Statement.
 5. This drawing is to be read in conjunction with:
 151666-TRA-00-HUL4-DRG-R-SG-310001 - Location Plan
 151666-TRA-00-HUL4-DRG-R-SG-310002 - Proposed Plan
 151666-TRA-00-HUL4-DRG-R-SG-310003 - Elevations West
 151666-TRA-00-HUL4-DRG-R-SG-310005 - Proposed Sections
 151666-TRA-00-HUL4-DRG-R-SG-310006 - Existing Sections

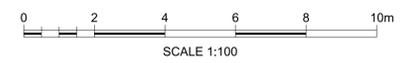

P01	04/07/23	First Issue	SW	MW	MW
Rev	Date	Description of Revisions	Drawn	Chkd	Appr
Status				Suitability	
					S2



Authorised: _____ Signed: [Electronically Signed](#) Date: _____

Contractor(s): **TRU Alliance**

Location		AREA BDY MICKLEFIELD TO LEEDS CITY STATION	
Type	CAD Drawing	Sub-type	Elevation
Role	Rail Engineering	Sub-Role	Signalling
Zone			
Phasing	Proposed	Project Stage	GRIP 4
Project			

Transpennine Route Upgrade

Contract No. **151666**

Contract Title **TRU - East of Leeds**


Drawing Title
**Listed Building Consent
Replacement Austhorpe Lane
Bridge
Elevations East**

Designed	O.McIntosh	Signed	Electronically Signed	Date	03/07/23
Drawn	S.Wilson	Signed	Electronically Signed	Date	03/07/23
Checked	M.Westwood	Signed	Electronically Signed	Date	04/07/23
Approved	M.Westwood	Signed	Electronically Signed	Date	04/07/23

Scale(s) **1:100** ELR & Mileage **15.1408** to **0**

Alternative Reference _____ Sheet _____ of _____

Drawing Number **151666-TRA-00-HUL4-DRG-R-SG-310004** Revision **P01**

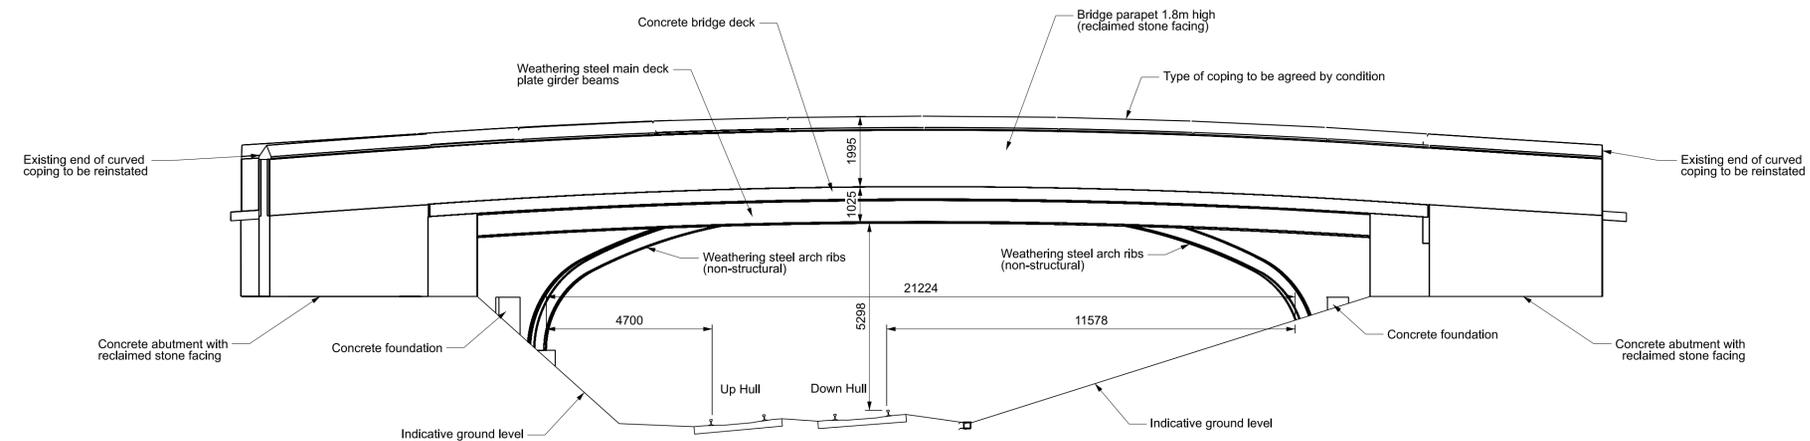

Elevation B-B Proposed: Road Bridge East Elevation

Scale 1:100

Published

Published